



NOTE
THE EXISTING DRAINAGE AND CONNECTIONS AS SHOWN HAVE BEEN TAKEN FROM A NUMBER OF SOURCES INCLUDING CCTV DRAINAGE SURVEY UNDERTAKEN BY METAKOD AND SITE SURVEY UNDERTAKEN BY JP STRUCTURAL DESIGN AND WILL NEED TO BE VERIFIED.
**** IT MUST BE CONFIRMED PRIOR TO THE ABANDONMENT OF ANY EXISTING DRAIN THAT THE DRAINAGE DOES NOT SERVE ANY AREA TO REMAIN.**

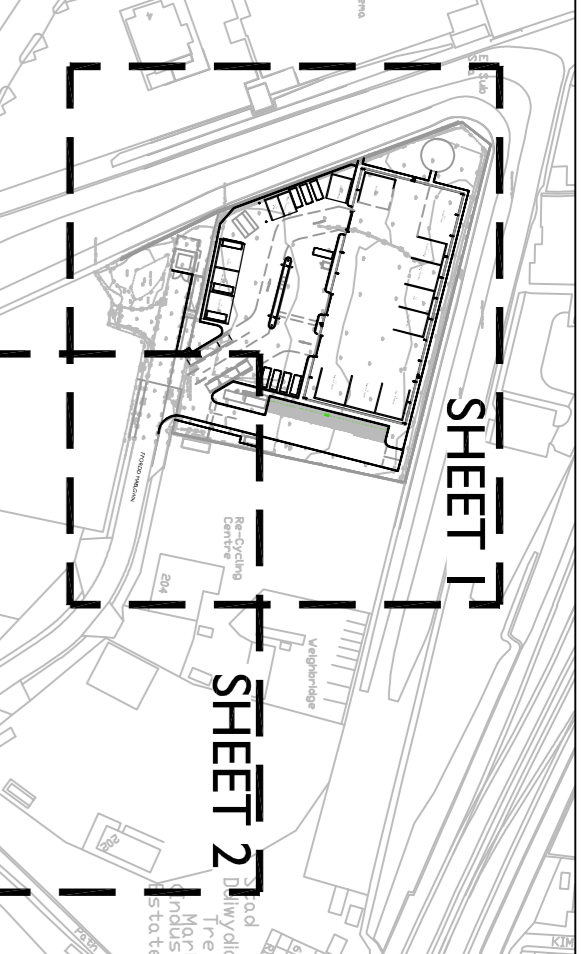

SITE PLAN
SCALE 1:2500

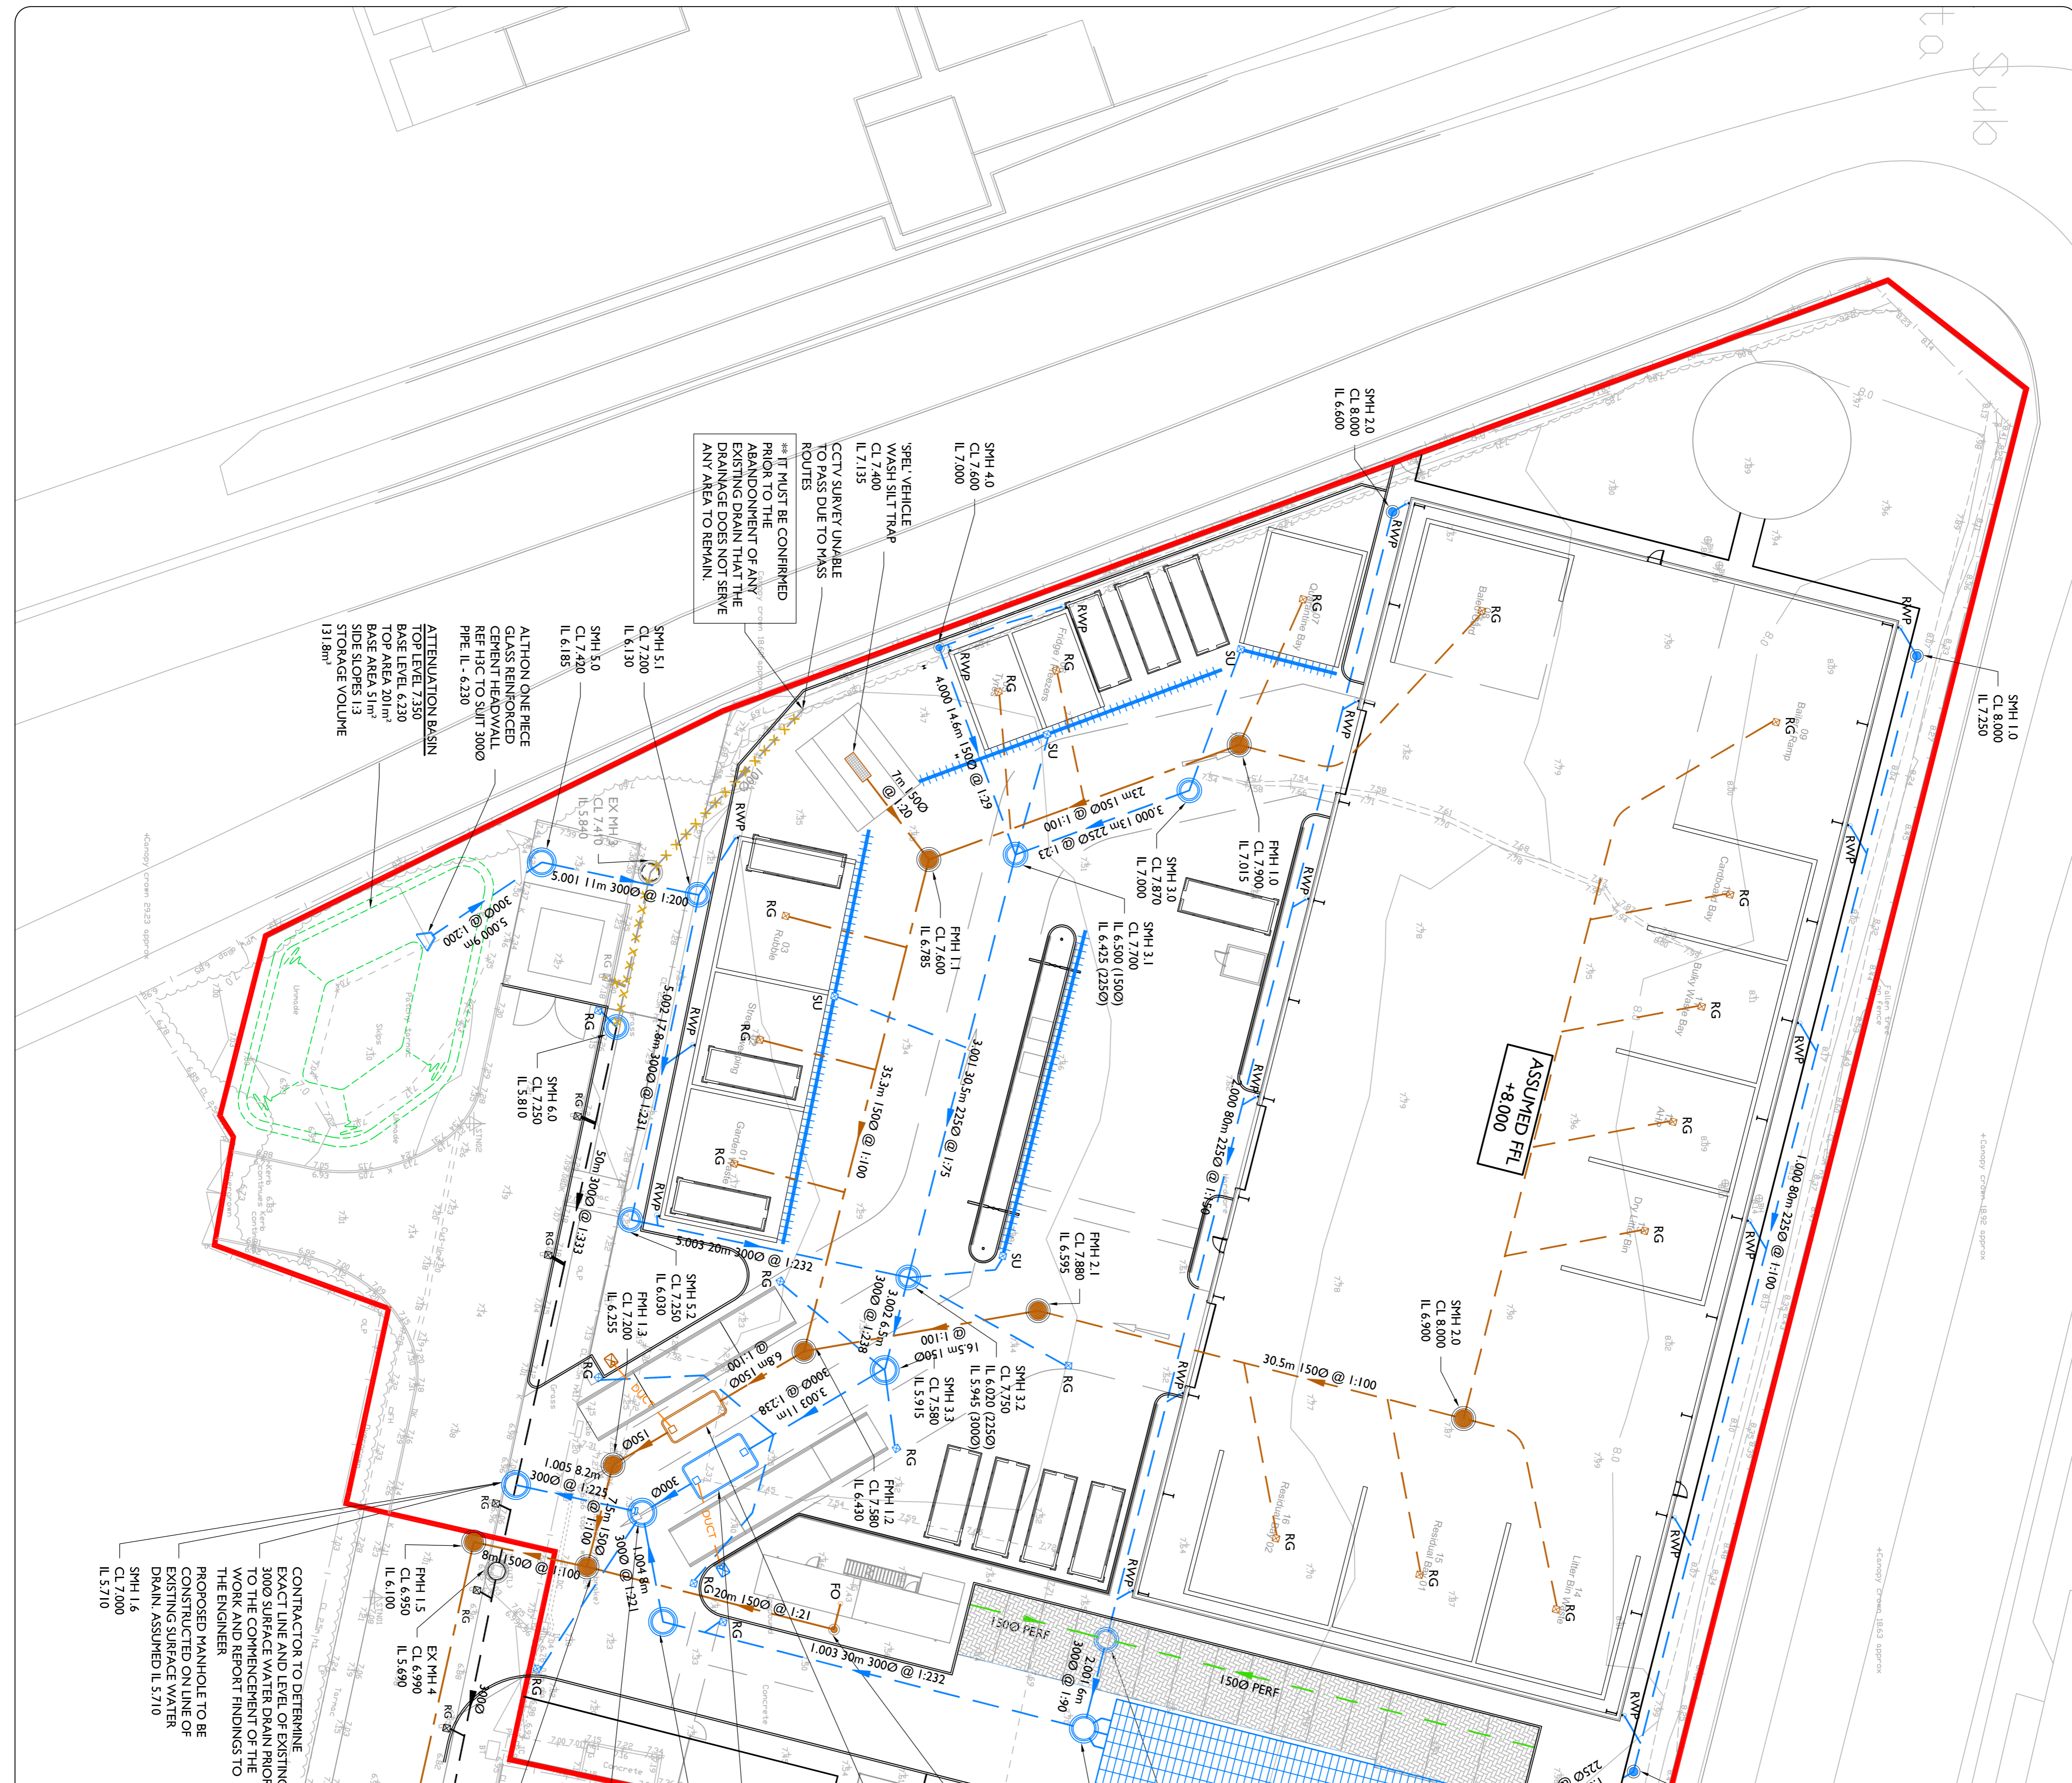

- SCF 1.2
CL 8.100
IL 6.010 (2350)
IL 5.935 (2000)
BL 5.635
(300mm SUMP)

- SMH 2.1
CL 7.950
IL 7.200 (1500 PERN)
IL 6.060 (2350)
IL 5.985 (2000)
BL 5.685
(300mm SUMP)

- SMH 2.0
CL 8.000
IL 6.900

- SMH 1.1
CL 8.000
IL 6.450

- SMH 1.0
CL 8.000
IL 7.250

- SMH 3.0
CL 7.870
IL 7.000

- SMH 3.1
CL 7.700
IL 6.425 (2350)

- SMH 3.2
CL 7.750
IL 6.020 (2350)
IL 5.945 (2000)
IL 5.615
(300mm SUMP)

- SMH 3.3
CL 7.580
IL 5.915

- SMH 5.3
CL 7.350
IL 6.030

- SMH 5.0
CL 7.400
IL 6.180

- SMH 5.1
CL 7.200
IL 6.130

- SMH 5.2
CL 7.400
IL 6.130

- SMH 5.4
CL 7.400
IL 6.130

- SMH 5.5
CL 7.200
IL 6.180




- SMH 5.6
CL 7.200
IL 6.180

- SMH 1.6
CL 6.500
IL 5.500

- SMH 1.7
CL 6.400
IL 5.250

NOTES

- THE WORKS SHALL BE IN ACCORDANCE WITH THE FOLLOWING SPECIFICATIONS: NATIONAL BUILDING SPECIFICATION (NBS) AND SEWERS FOR ADOPTION 7TH EDITION
- THIS DRAWING IS TO BE READ IN CONJUNCTION WITH ALL RELEVANT ENGINEERS DRAWINGS, ARCHITECTS DRAWINGS, MECHANICAL AND ELECTRICAL DRAWINGS AND SPECIFICATIONS
- THE LOCATION, LINE & LEVEL OF ALL KNOWN EXISTING BURIED SERVICE MAINS AND DRAINAGE NETWORK INDICATED ON THE DRAWINGS ARE APPROXIMATE AND FOR GUIDANCE PURPOSES ONLY. EXISTING SERVICE MAINS AND DRAINAGE NETWORKS SHALL NOT BE ABANDONED PRIOR TO THE COMMENCEMENT OF ANY EXCAVATION WORKS ON SITE. THE CONTRACTOR SHALL TAKE ALL NECESSARY PRECAUTIONS TO IDENTIFY AND MARK EXISTING SERVICE MAINS AND DRAINAGE NETWORKS. GROUND SERVICE MAINS / DRAINAGE INSTALLATIONS.
- THE CONTRACTOR MUST COMPLY WITH ALL CURRENT LEGISLATION RELATING TO HEALTH & SAFETY.
- THE MAIN CONTRACTOR IS RESPONSIBLE FOR THE DESIGN OF ALL TEMPORARY WORKS AND IS ALSO RESPONSIBLE FOR THE SAFE MAINTENANCE AND STABILITY OF EXISTING BUILDINGS AT ALL TIMES.
- ALL OCCURRENCES OF GROUND WATER DURING THE CONSTRUCTION PERIOD.
- THE CONTRACTOR SHALL MAKE ALLOWANCE FOR RAISING / LOWERING ALL EXISTING ACCESS COVERS & RAMPERS TO SURFINW FINISHED LEVELS.
- ALL SOFT / HARD PAVED AREAS AFFECTED BY THE WORKS SHALL BE REPLACED PRIOR TO THE COMMENCEMENT OF THE WORKS. ALL SURFACE FINISHES SHALL BE MATCHED TO THE EXISTING FINISHES. ALL SURFACE FINISHES SHALL BE MATCHED TO THE EXISTING FINISHES. ALL SURFACE FINISHES SHALL BE MATCHED TO THE EXISTING FINISHES.
- ALL SURPLUS EXCAVATED MATERIAL SHALL BE DISPOSED OF OFF SITE.
- ALL LEVELS ARE TO ORDNANCE DATUM

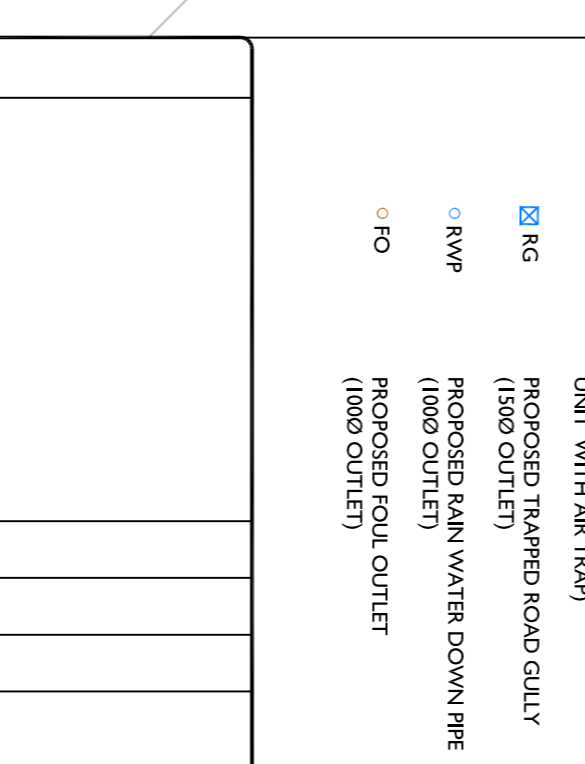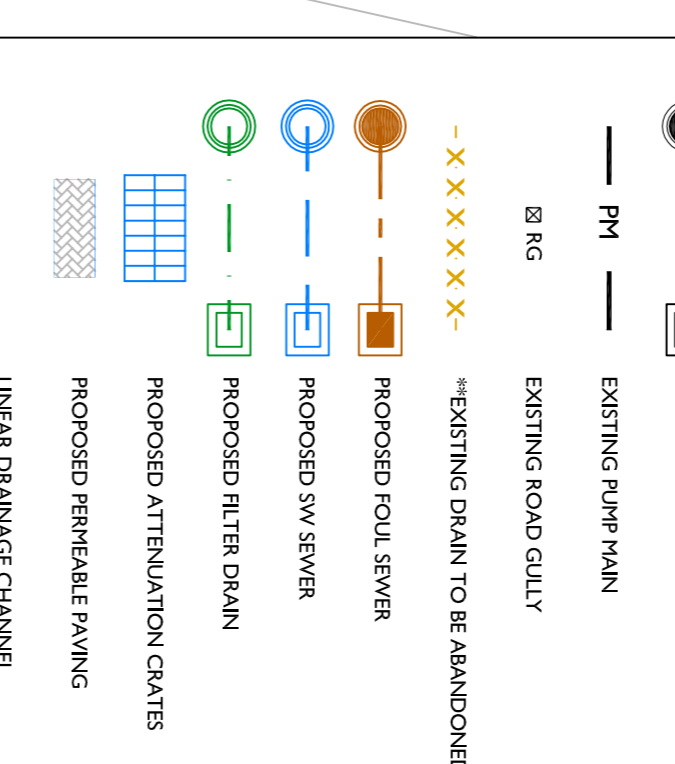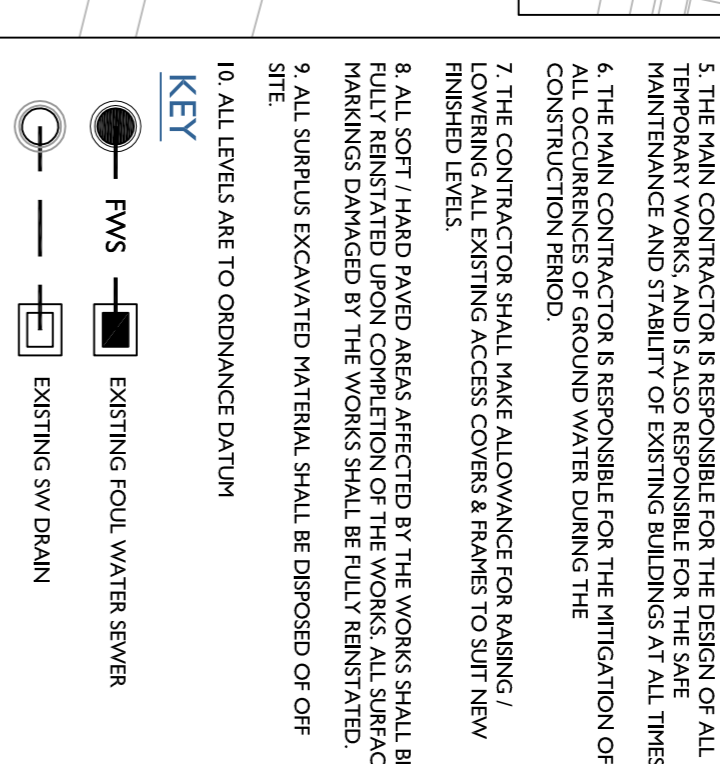

| REV | DESCRIPTION | BY | CHK | DATE |
|-----|-------------|----|-----|------|
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|--|------------------------------|----------------|--|
| JPS CIVIL + STRUCTURAL ENGINEERS 44 (0) 24 893498 www.jpstructural.co.uk info@jpstructural.co.uk | | PROJECT | LANDUDNO JUNCTION WASTE TRANSFER SITE |
| | | TITLE | DRAINAGE SCHEME PROPOSED LAYOUT 1 OF 2 |
| CLIENT | CONWY COUNTY BOROUGH COUNCIL | STATUS | |
| PRELIMINARY | | P | |
| RANGE OF ISSUE | | | |
| DATE | 27.06.2023 | SCALE | (@ A1) 1:250 |
| DRAWN BY | JR | CHECKED BY | RH |
| APPROVED BY | JP | PROJECT NUMBER | 16019 |
| DRAWING NUMBER | LJW-JPS-XX-XX-DR-C-0502 | REV | P01 |